1917 Euclid Avenue Project Description `

The project scope is to replace the existing home with a new modern steel and glass two storey home with a site built two car garage. A deck will be added to the roof of the garage. In the back yard a deck will be added to the home and an existing structure will be converted to an ADU.

The main modular home will be black Corten steel with cedar accents. The site-built garage will be white and cedar siding with a vertical bi fold door. The roof top deck will be wood framed. The railing will be an engineered steel with glass partitions. The back deck will be site-built wood structure with an engineered glass guardrail system.

There is an existing leisure structure that will be converted into a functional ADU. Proposed work includes formal development and legalization of kitchen to meet criteria of ADU. No exterior alterations required or proposed.

HONOMOBO - HO709 (HS8)

SOOREDDY RESIDENCE

1917 EUCLID AVE, MENLO PARK. CALIFORNIA, USA, 94025

063-472-020

GENERAL CODE COMPLIANCE - CALIFORNIA, USA

THESE PLANS ARE IN COMPLIANCE WITH THE FOLLOWING ADOPTED CALIFORNIA STATE REGULATIONS. ANY ERRORS OR OMISSIONS DO NOT WAIVE CODE REQUIREMENTS.

- · 2022 PART 2.5 CA RESIDENTIAL CODE w/ 2024 SUPPLEMENT

- 2002 PART 3 CA RESIDENTIFIC CODE W 2024 SUPPLEMENT
 2002 PART 3 CA RECETTRICAL CODE W 2024 SUPPLEMENT
 2022 PART 3 CA PILLMBING CODE W 2024 SUPPLEMENT
 2022 PART 5 CA PILLMBING CODE W 2024 SUPPLEMENT
 2022 PART 5 CA ENERGY CODE W 2024 SUPPLEMENT
 2022 PART 10 CA EVISTING BUILDING CODE W 2024 SUPPLEMENT
 2022 PART 11 CA GREEN BUILDING STANDARDS CODE
- (CALGREEN) w/ 2024 SUPPLEMENT 2022 Part 9 CA Fire Code w/ 2024 Supplement

ALONG WITH ALL OTHER APPLICABLE STATE
AND LOCAL LAWS ORDINANCES AND REGULATIONS.

ITEMS TO BE COMPLETED ON SITE:

THE FOLLOWING WORK IS TO BE PERFORMED ON SITE (WHEN THE POLLOWING WORK IS TO BE PERFORMED ON SITE (WHEN REQUIRED) BY A QUALIFIED CONTRACTOR AND ARE NOT INCLUDED AS PART OF THE FACTORY BUILT PORTION OF THE BUILDING. QUALIFIED CONTRACTOR SITE SCOPE ITEMS MAY INCLUDE, BUT ARE NOT LIMITED TO:

· FOUNDATION AND SITE BUILT COMPONENTS

MODULAR UNITS THAT ARE TO BE PERFORMED AT THE SITE AND NOT INCLUDED IN FACTORY BUILT PORTION OF THE BUILDING:

- · PLACE HOUSE ON FOUNDATION
- HOME CONNECTION TO FOUNDATION
- B. WATER-BY OTHERS C. SEWER/SEPTIC BY OTHERS D. STORM WATER BY OTHERS

- LANDINGS, DECKS AND/OR GUARDS BY OTHERS
 INSULATE UNDERSIDE OF HOME WHEN REQUIRED

Minimum Required DC System Size - (kWdc) - 3.07

罪 IAQ Ventilation System: as low as 0.36 W/CFM 類 IAQ Ventilation System Heat Recovery: minimum 77 SRE and 80 ASRE 観 IAQ Ventilation System: supply outside air inlet, filter, and H/ERV cores accessible per

BUILDING INFORMATION:

 STAIRCASE:
 GARAGE: 8'-0" X 26"-0" = 208 SF 24'-0" X 20'-0" = 480 SF

· OCCUPANCY TYPE: SINGLE FAMILY RESIDENTIAL



- · UTILITY TIE-INS & SITE SERVICES · ALL SITE WORKS/GRADING/LANDSCAPING

THE FOLLOWING ARE THE WORK RELATED TO THE APPROVED

- INTERCONNECT UTILITIES:

- EXTERIOR:
 CONNECT MODULAR UNIT TO FOUNDATION @ MODULE CONNECTIONS
 A. INSTALL INSULATION @ CAVITY VOIDS @ MATELINES

- A. INSTALL PROJECT ENVISION (9 CAVITY YOUNDS (9 M TELINES).

 LAP & SEAL ROOF MEMBRANE (9 PARAPETS).

 C. INSTAL CAP FLASHING (PARAPETS).

 LAP & SEAL VERTICAL CONNECTIONS
 E. INSTALL STALL FLASHINGHARDIE (9 VERTICAL CONNECTIONS F. INSTALL SOTTE FINISHING). BATTELINES
 INSTALL GUTTER SINISHING (MATELINES).

 INSTALL GUTTERS AND DOWNSPOUTS

III IAQ Ventilation System: fault indicator display

- AT MODULE CONNECTIONS:
 A. FLOOR LEVELER AT INTERIOR MATELINES.
- A FLOOK LEVELER AT INTERIOR MATELINES
 B. DRYWALL, TAPE AND COAT AT WALL MATE LINES
 C. CABINET INSTALL IN INTERCONNECT AREAS
 PLACE KITCHEN ISLAND AND CABINETS AT MOD LINE
 CONNECT DUCTWORK BETWEEN MODULES
 ELECTRICIAN TO CONNECT WIRING BETWEEN MODULES AND
 TO LINES BY OTLEPS
- TO HOME-BY OTHERS

 BLOWER DOOR TESTING AND CERTIFICATION
- WHEN REQUIRED BY OTHERS

 SPRINKLERS DESIGNED AND INSTALLED BY OTHERS

- TEMP POWER SERVICE BY OTHER
 PERMANENT SERVICE LINE AND METER PANEL BY OTHER
 UNDER GROUND CONNECTION BY OTHER
- MODULE TO MODULE ELECTRICAL CONNECTIONS

- FIRE SUPPRESSION:

- FIRE EXTINGUISHERS TO BE SUPPLIED AND INSTALLED
 ON SITE BY OTHERS IN ACCORDANCE WITH
- 2022 CRC R313.2 OR NFPA 13D-2022
 FIRE SUPPRESSION SYSTEMS TO BE SITE INSTALLED BYLICENSED CONTRACTOR IN ACCORDANCE WITH 2022 CRC R313.2 OR NFPA 13D-2022

* IMAGE FOR ILLUSTRATION PURPOSES ONLY. FINAL PRODUCT MAY NOT BE EXACTLY AS SHOWN

1.AS A MINIMUM ALL CONSTRUCTION PRACTICES TO COMPLY WITH THE MOST CURRENT BUILDING CODE ANDIOR APPLICABLE BY-LAWS AND REGULATIONS OF LOCAL AUTHORITIES HAVING JURISDICTION. INCLUDING THEIR ADDENDA AND REFERENCED STANDARDS.

2. CONTRACTOR SHALL KEEP JOB SITE FREE OF TRASH AND GARBAGE, AND SHALL IMMEDIATELY COLLECT ANY

3.IT IS THE CONTRACTOR AND/OR OWNERS RESPONSIBILITY TO INFORM THEMSELVES OF THE EXACT LOCATION OF AND ASSUME ALL LUABILITY FOR DAMAGE TO ALL POLE LINES, CONDUITS, WATER MAINS, SEWERS + ALL UNDERSROUND AN ABOVE GROUND INTLINES AND TRUCTURES BEFORE COMMENCING WORK SUCH DETAIL MAY OR MAY NOT BE SHOWN ON THESE DRAWINGS AND THEIR LOCATION IF SHOWN MAY NOT BE EXACT.

4. ALL INTERIOR DOORS TO BE 3" FROM CORNER UNLESS NOTED OTHERWISE.

5. DRAWINGS ARE NOT TO BE SCALED UNDER ANY CIRCUMSTANCES. OBTAIN ACCURATE DIMENSIONS FROM SITE

6. ALL MECHANICAL, ELECTRICAL, STRUCTURAL, AND ARCHITECTURAL COMPONENTS MUST BE COORDINATED BY THE CONTRACTOR CONTRACTOR MUST REPORT ANY DISCREPANCIES THAT EXIST PRIOR TO COMMENCEMENT OF WORK.

9. ALL FLOOR DRAIN AND VENT LOCATIONS TO BE VERIFIED BY CONTRACTOR

10. THE FOLLOWING PROJECT IS HCD CERTIFIED MODULAR UNIT AND LABELED AS SUCH.

8.ALL PENETRATIONS (WINDOWS, ELECTRICAL WIRING & BOXES, PIPING, ETC.) IN VAPOUR BARRIER TO BE SEALED WITH ACOUSTIC SEALANT

9. METHODS OF FLASHING MUST CONFORM TO CODE. FLASHING IS REQUIRED IN ALL ROOF PARAPETS INCLUDING

BUILDING SEPERATION- A 1" MINIMUM STRUCTURAL GAP SHALL BE PROVIDED BETWEEN THE APPROVED MODULAR BUILDING AND ALL ADJACENT STRUCTURES IN EACH ORTHOGONAL DIRECTION

DRAWING LIST	NUMBER
COVER	A(A)000
SITE PLAN	A(A)100
FOUNDATION PLAN	A(A)101
MAIN FLOOR PLAN	A(A)102
SECOND FLOOR PLAN	A(A)103
ROOF PLAN	A(A)104
ELEVATIONS PROJECT NORTH & PROJECT SOUTH	A(A)201
ELEVATIONS PROJECT EAST & PROJECT WEST	A(A)202
BUILDING SECTIONS - 1	A(A)301
BUILDING SECTIONS - 2	A(A)302
UNIT TO SITE BUILT ARCHITECTURAL DETAILS @ INSTALL - 1	A(A)501
UNIT TO SITE BUILT ARCHITECTURAL DETAILS @ INSTALL - 2	A(A)502
UNIT TO SITE BUILT ARCHITECTURAL DETAILS @ INSTALL - 3	A(A)503
SITE BUILT ARCHITECTURAL DETAILS - 1	A(A)504
SITE BUILT ARCHITECTURAL DETAILS - 2	A(A)505


PROJECT BUILDER / PRIME CONSULTANT $N \square M \square B \square$ 8603 104 Street NW Edmonton, AB Canada


MODULAR COMPONENTS MANUFACTURED AT


THIS DRAWING CONTAINS CONFIDENTIAL AND PROPRIETARY INFORMATION, ITS CONTENTS SHALL NOT BE DISCLOSED TO OTHER PARTIES, NOR MAY ITS CONTENTS BE REPRODUCED OR DISCLOSED IN WHOLE OR IN PART, OR BE USED TO MANUFACTURE FOR USE OF SALE BY MY OTHER PERSON WITHOUT PRIOR WRITTEN CONSENT HOMOMOBIO.

COVER

24_250110_HO709_SITE_CM.rvt DRAWN BY MV 2025.05.01 CHECKED A(A)000

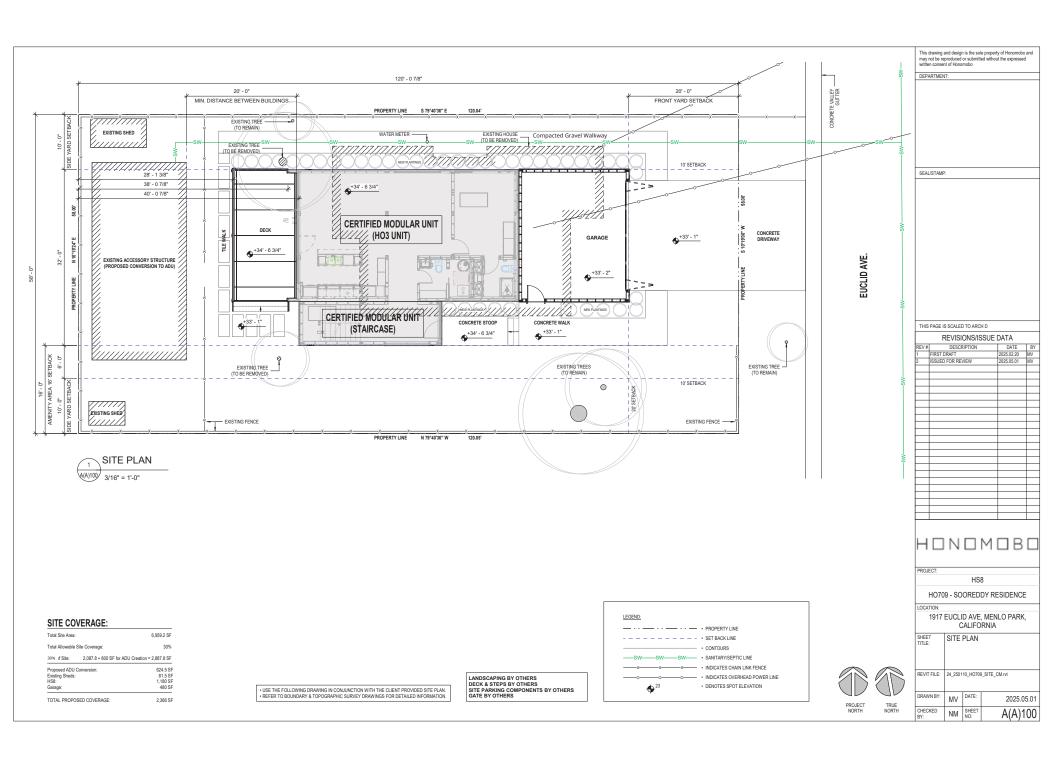

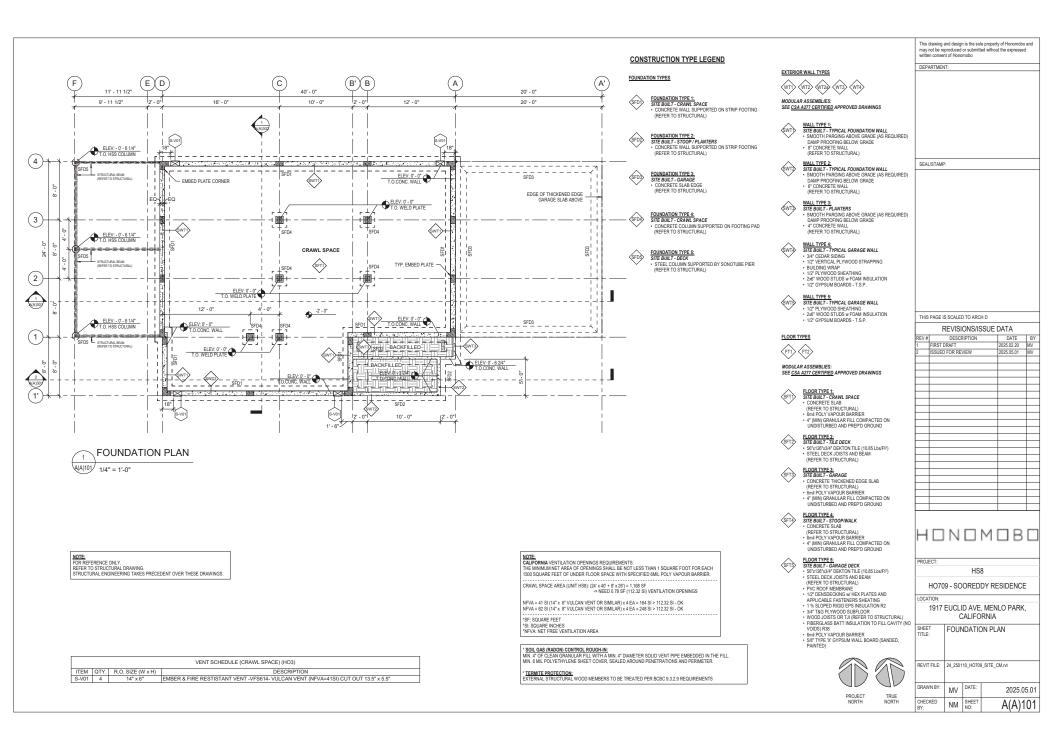

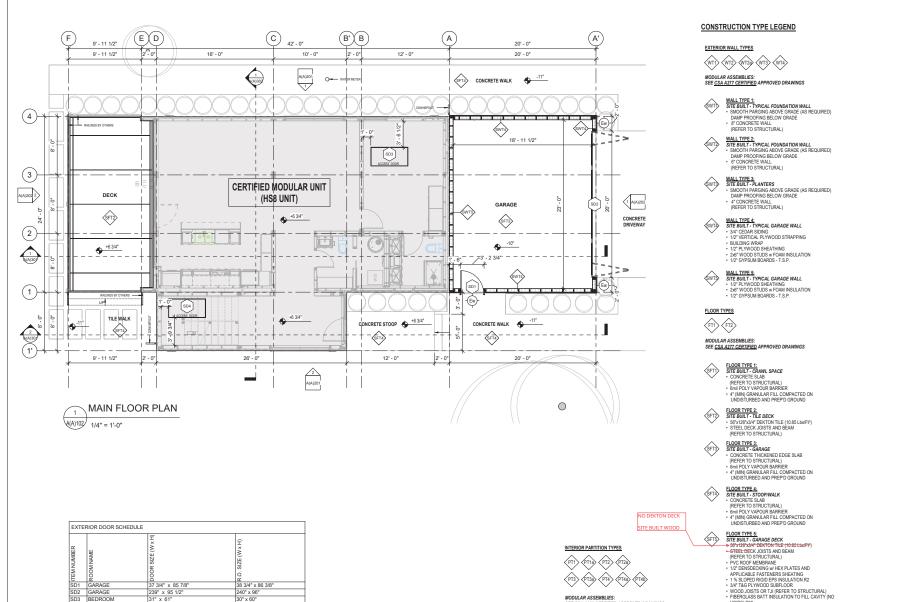

MODULAR ASSEMBLIES:

SEE CSA A277 CERTIFIED APPROVED DRAWINGS

VOIDS) R38 • 6mil POLY VAPOUR BARRIER

5/8" TYPE 'X' GYPSUM WALL BOARD (SANDED.

37 3/4" x 85 7/8"

239" x 95 1/2"

SD3 BEDROOM SD4 ENTRY

38 3/4" x 86 3/8"

240" x 96"

30" x 60"


30" x 60"

This drawing and design is the sole property of Honomobo and may not be reproduced or submitted without the expressed written consent of Honomobo DEPARTMENT: SEAL/STAMP: THIS PAGE IS SCALED TO ARCH D REVISIONS/ISSUE DATA DESCRIPTION DATE FIRST DRAFT 2025.02.20 MN ISSUED FOR REVIEW HONOMOBO PROJECT: HO709 - SOOREDDY RESIDENCE LOCATION: 1917 EUCLID AVE, MENLO PARK, CALIFORNIA MAIN FLOOR PLAN REVIT FILE: 24 250110 HO709 SITE CM.rvt MV DATE: DRAWN BY 2025.05.01

CHECKED

NM

A(A)102

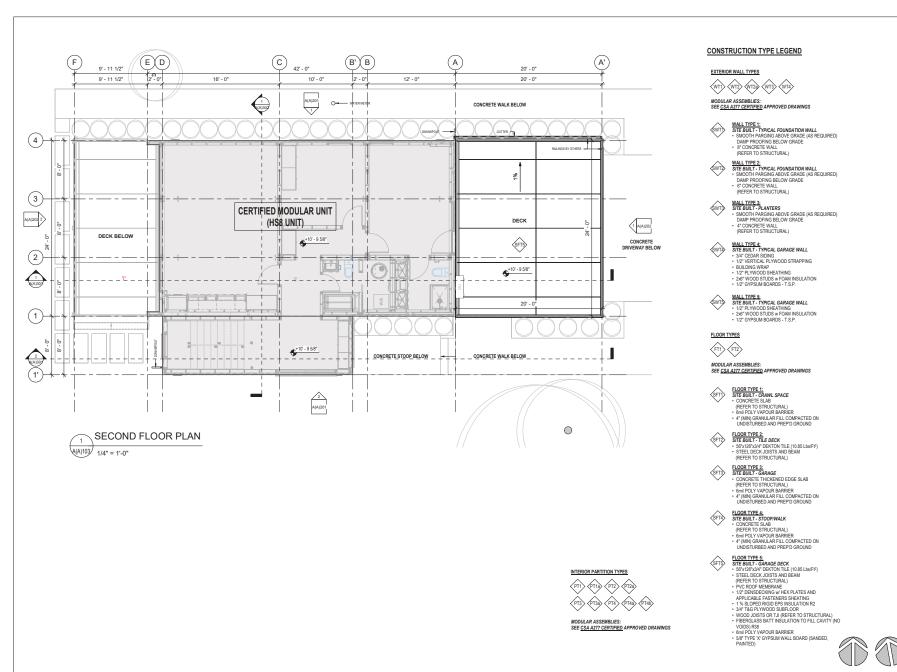

	This may writte	drawing not be re in conse	and design is the sole proper produced or submitted without nt of Honomobo	ty of Honomob ut the expresse	o and d		
	DEP	ARTMEN	Œ:				
	SEAL	/STAME	•				
	THIS		S SCALED TO ARCH D				
	REV#		DESCRIPTION	DATA	BY		
	1	FIRST [DRAFT	2025.02.20	MV		
	2	ISSUED	FOR REVIEW	2025.05.01	MV		
	_				\vdash		
		_	—				
	Н		$N \square M$	$\square B$			
	PROJ	ECT:	1100				
		HS8					
	l	HO709 - SOOREDDY RESIDENCE					
	LOCATION: 1917 EUCLID AVE, MENLO PARK,						
		191/	CALIFORNIA		٠,		
	l						
	SHEE	Т	SECOND FLOOR				
	SHEE	T					
<u> </u>	SHEE			PLAN			

MV DATE:


NM SHEET NO:

2025.05.01

A(A)103

DRAWN BY:

CHECKED

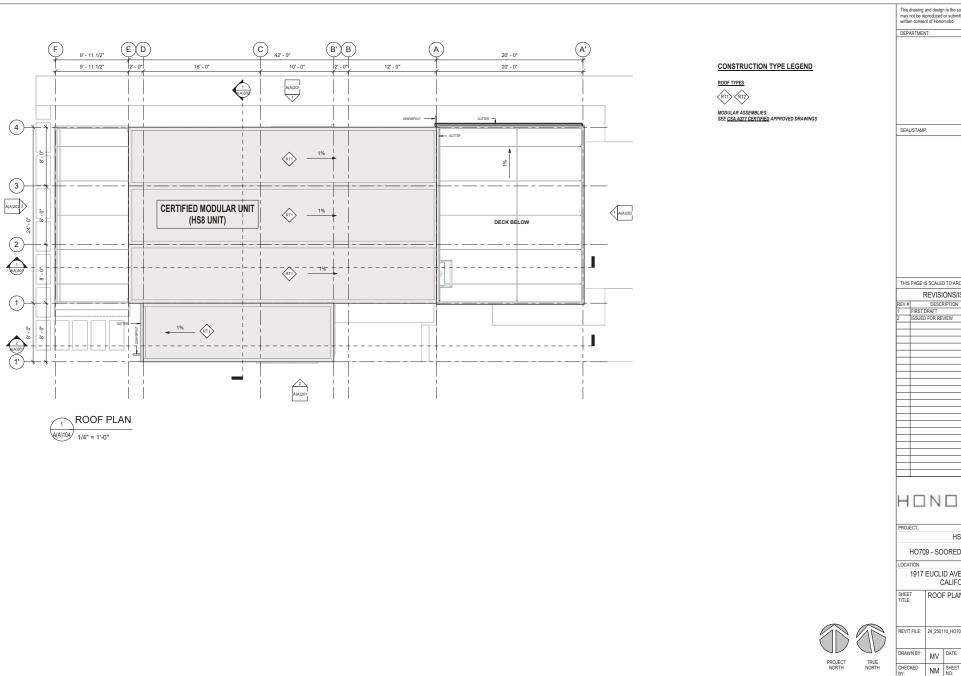


This drawing and design is the sole property of Honomobo and may not be reproduced or submitted without the expressed written consent of Honomobo THIS PAGE IS SCALED TO ARCH D REVISIONS/ISSUE DATA REV# DESCRIPTION


1 FIRST DRAFT


2 ISSUED FOR REVIEW DATE BY 2025.02.20 MV 2025.05.01 MV HONOMOBO HO709 - SOOREDDY RESIDENCE 1917 EUCLID AVE, MENLO PARK, CALIFORNIA ROOF PLAN REVIT FILE: 24_250110_HO709_SITE_CM.rvt


2025.05.01

A(A)104

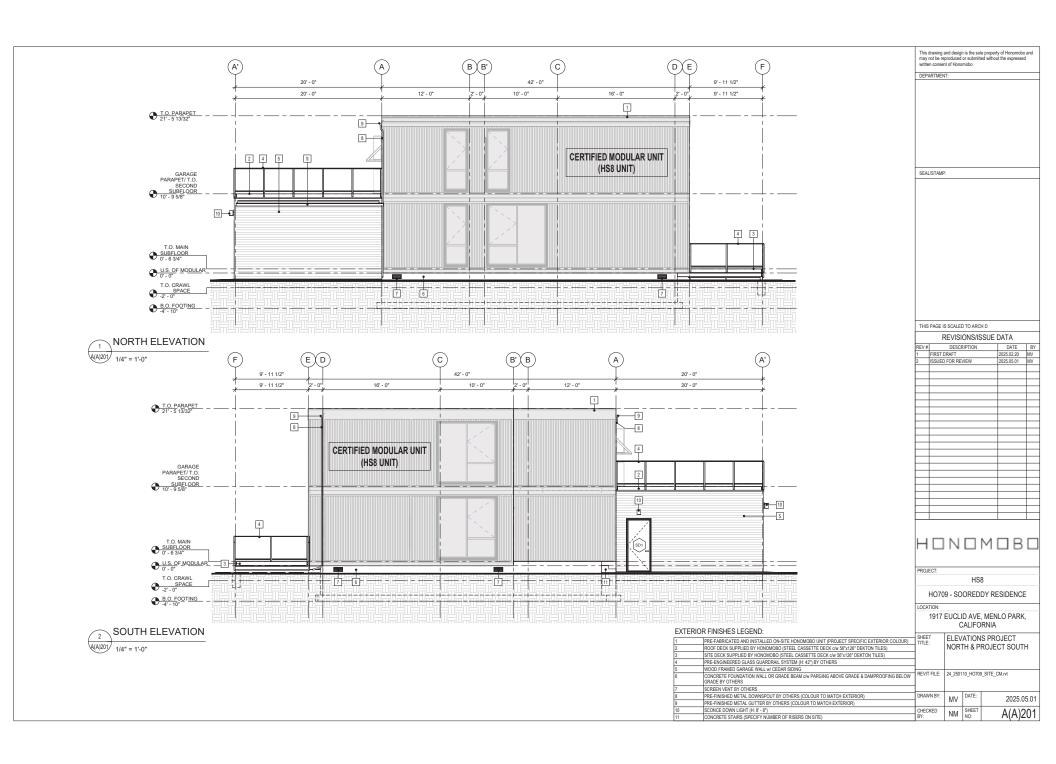

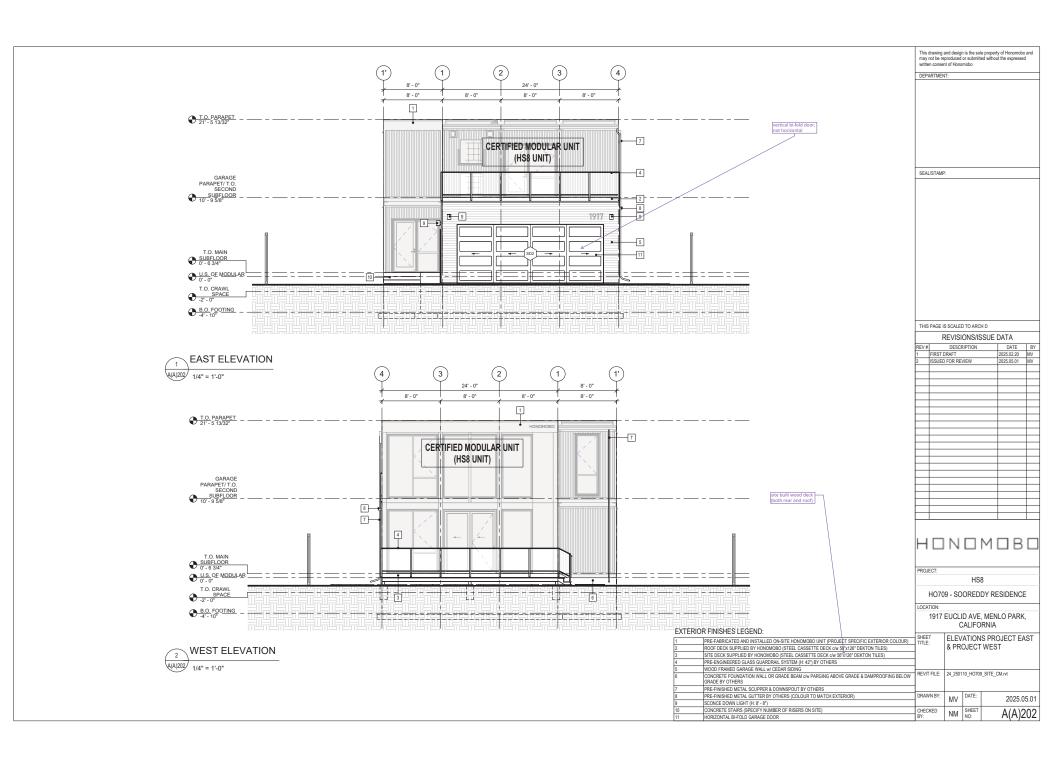

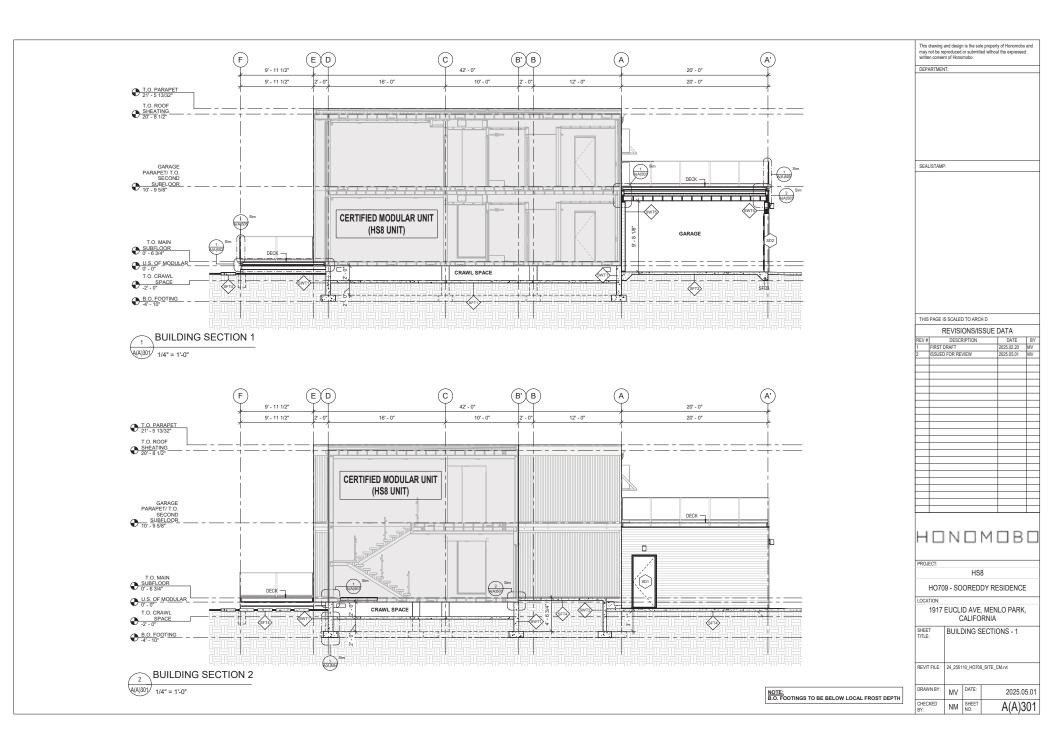

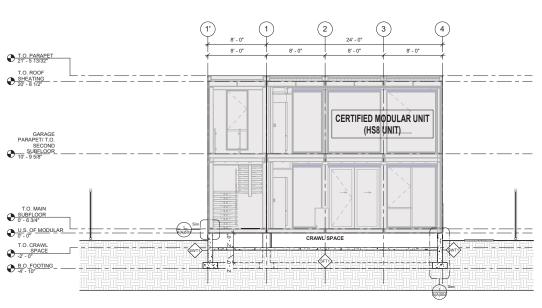



BUILDING SECTION 3


	ARTMEN	√T:				
051						
SEA	L/STAMF	*:				
THIS	PAGE	S SCALE	TO ARC	H D		
TITIC			ONS/IS		ΠΔΤΔ	
REV#		DESCR	RIPTION	JUL	DATE	BY
1 2	FIRST	DRAFT FOR RE			2025.02.20 2025.05.01	MV
	ISSUEL) FUR RE	VIEW		2020.00.01	MV
						F
						+
						+
_						
		N N		M	□В	
H PROJ		N	HS		□В	
PROJ	ECT:		HS	В	B	
PROJ	ECT: HO70)9 - SO	HS:	B DY RE	ESIDENC	E
PROJ	ECT: HO70	9 - SO	HS:	B DY RE		E
PROJ	HO70	9 - SO	HSi OREDI D AVE	B DY RE , MEN RNIA	ESIDENC	E
PROJ LOCA SHEE TITLE	HO70 TION: 1917	BUILI	HSi OREDI D AVE CALIFO DING S	B DY RE , MEN RNIA ECTI	ESIDENCI ILO PARM ONS - 2	E
PROJ LOCA SHEE TITLE	HO70	BUILI	HSi OREDI D AVE	B DY RE , MEN RNIA ECTI	ESIDENCI ILO PARM ONS - 2	E
LOCA SHEE	HO70 TION: 1917 T FILE:	BUILI	HSi OREDI D AVE CALIFO DING S	B DY RE , MEN RNIA ECTI	ESIDENCI ILO PARM ONS - 2	E (,

This drawing and design is the sole property of Honomobo and may not be reproduced or submitted without the expressed

NOTE; B.O. FOOTINGS TO BE BELOW LOCAL FROST DEPTH

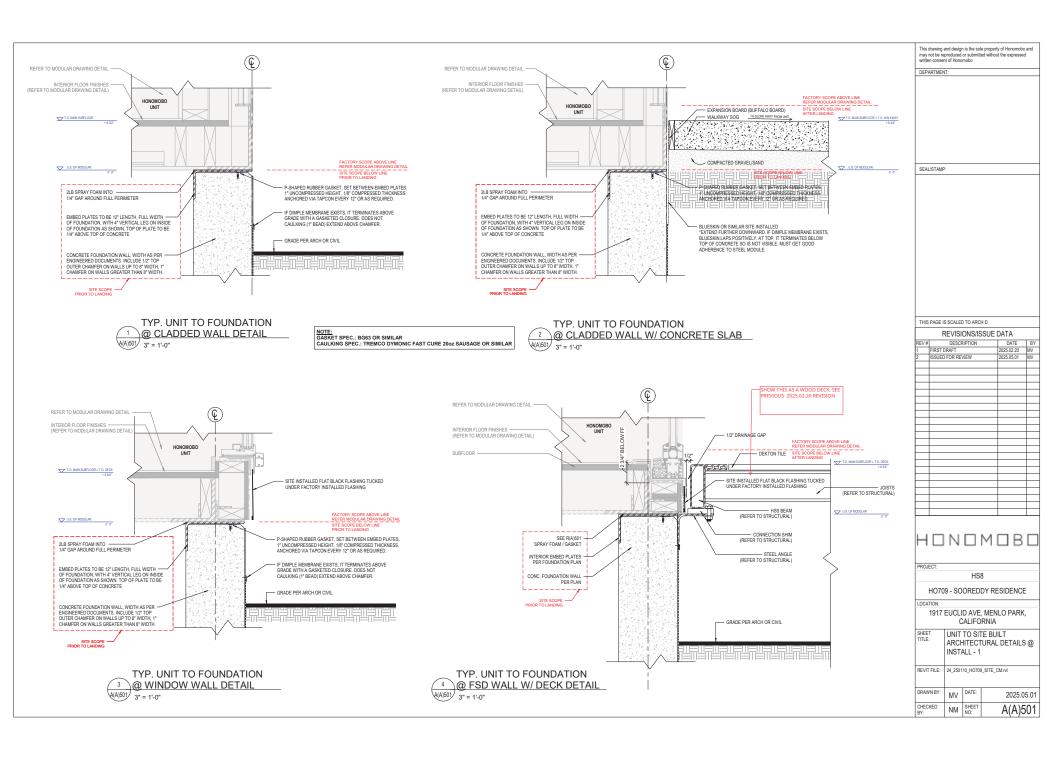

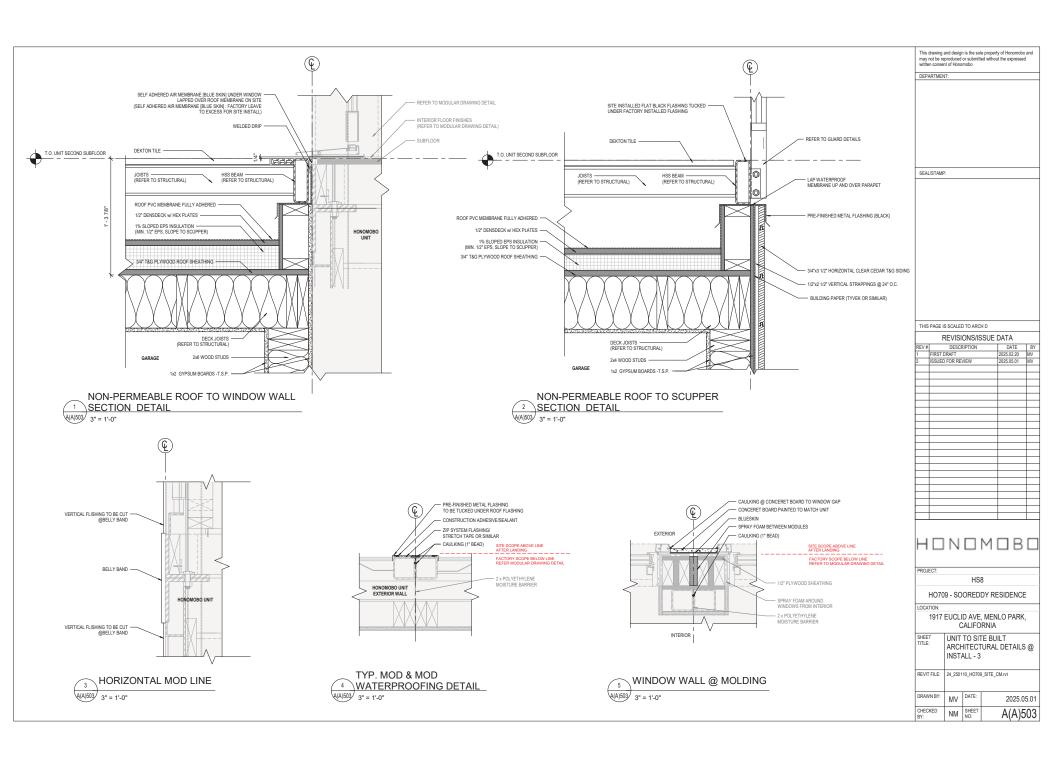


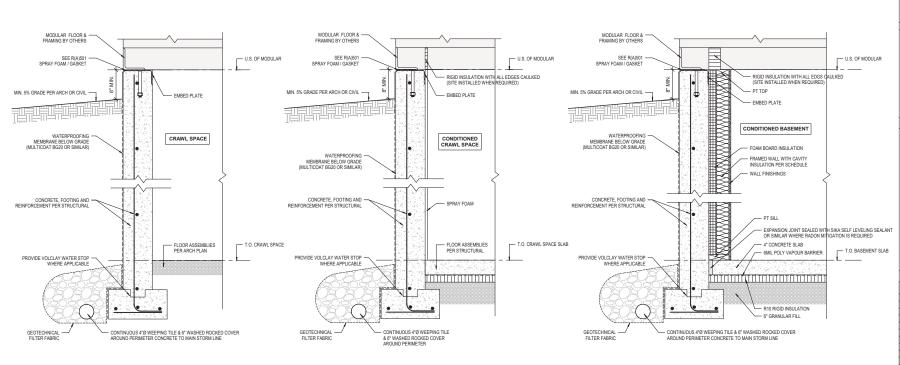

TYP. CRAWL SPACE FOUNDATION SECTION A(A)504 1 1/2" = 1'-0"

TYP. CONDITIONED CRAWL SPACE FOUNDATION SECTION A(A)504 1 1/2" = 1'-0"

CONDITIONED BASEMENT FOUNDATION SECTION A(A)504 1 1/2" = 1'-0"

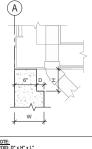


* <u>NOTE:</u> • VOID: D" x H" x L" SEE PLAN VIEW FOR LENGTH(L) & DEPTH(D) & LOCATION
 REINFORCEMENT PER STRUCTIRAL PLAN


TYP. FOUNDATION VOID SPEC A(A)504

DEPARTMENT: SEAL/STAMP: THIS PAGE IS SCALED TO ARCH D REVISIONS/ISSUE DATA DESCRIPTION DATE FIRST DRAFT 2025.02.20 MV SSUED FOR REVIEW HONOMOBE PROJECT: HO709 - SOOREDDY RESIDENCE LOCATION: 1917 EUCLID AVE, MENLO PARK, CALIFORNIA SITE BUILT ARCHITECTURAL DETAILS - 1 REVIT FILE: 24 250110 HO709 SITE CM.rvt MV DATE: DRAWN BY 2025.05.01 CHECKED NM SHEET NO: A(A)504


This drawing and design is the sole property of Honomobo and may not be reproduced or submitted without the expressed written consent of Honomobo

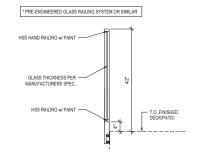


TYP. GLASS GUARD RAILING DETAIL

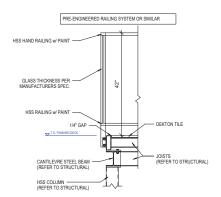

DECK & GUARD RAILING DETAIL w/ STEEL RIM

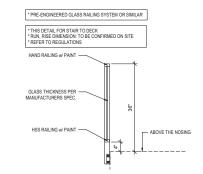

TYP. GLASS HAND RAILING DETAIL

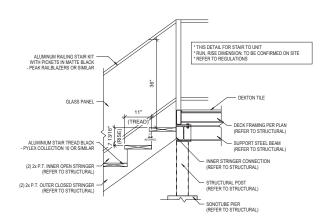

STAIRS & DECK BEAM CONNECTION DETAIL

			n is the sol or submitt mobo	e proper ed withou	ty of Hor ut the ex	nomobo	and
DEP	ARTMEN	П:					
SEAL	/STAMF	·:					
THIS			D TO ARC				
			ONS/IS	SSUE			
EV#	FIRST	TRAFT	RIPTION		2025.0	ATE 2.20	BY MV
	ISSUED	FOR RE	VIEW		2025.0	5.01	MV
_							
4	П	N		М	П	R	Г
	_			' '	_	_	_
DO II	ECT:						
ROJ	EUI.		HS	8			
	⊔∩ 7∩	0 90	ORED		SIDE	-NICE	
		9 - 30	UKED	ואזע	וטוטב	INCE	_
	TION: 1917	FUCL	D AVE	MEN	II O P	ARK	
		(CALIFO	RNIA		,	,
HEE	Т	SITE	BUILT	ARCH	HITEC	TUR	AL
IILE		DETA	AILS - 2				
REVIT	FILE:	24_2501	10_H070	SITE_	CM.rvt		
RAW	/N BY:	MV	DATE:		20	25.0	5.01

A(A)505

CHECKED BY:

NM SHEET NO: