Planning Division
City of Menlo Park
City Hall - 1st Floor
701 Laurel St. Menlo Park, CA 94025
(650) 330-6717



Project Name: Suri Residence

Project Address: 763 College Ave, Menlo Park, CA 94025

Date: 10/13/2025

Project Description Letter

To Whom It May Concern,

The existing single-story, non-sprinklered residence at 763 College Avenue embodies the character of early Allied Arts homes, featuring smooth stucco walls, arched openings, and a gently sloped roofline over a conventional raised-floor, spread-footing foundation. Originally built in 1926 under the building standards of its time, the structure remains in reasonable condition, showing no evidence of major structural distress or conditions that pose risk to persons or property.

While the existing residence is in good condition, it lacks the advantages of current building codes—such as enhanced seismic performance, energy efficiency, and fire safety. The proposed project includes replacing the existing structure with a new two-story Contemporary-style residence with a basement, comprising six bedrooms, six full bathrooms, and two half bathrooms, along with an attached two-car garage. In addition, a detached two-bedroom, one-bathroom Accessory Dwelling Unit (ADU) is proposed at the rear of the property.

The new residence will be constructed in full compliance with current California Building Standards, employing modern materials and methods and incorporating a complete fire sprinkler system. The proposed exterior finishes will include smooth stucco, stained horizontal cedar siding, 8-foot glass doors, clad wood windows with painted trims, painted wood fascia, and a high-quality standing seam metal roof with a metal-and-glass garage door. The design makes more efficient use of the site while maintaining aesthetic compatibility with the City's design guidelines and the surrounding neighborhood context. Landscape and site improvements will incorporate green building principles, water-efficient planting, and materials consistent with both the site's character and sustainability goals.

We believe the proposed residence will be a thoughtful and high-quality addition to the neighborhood, respecting the existing character while providing modern livability and environmental performance. The complete set of scaled architectural plans is submitted under separate cover.

Please do not hesitate to contact me with any questions or comments.

Sincerely,

Lerika Liscano, EIT Vylco, Inc.



4750 Almaden Expy, Suite 124-176, San Jose, CA 95118

Direct: (415) 559-1081



ABBREVIATIONS I LIL INVILLATION IN INTERPRETATION OF A REAL Inside Simeter
Inclusive, including Invest in Inclusive Inclusive Investigation Inves Asphalt Concre
Addison
Block
Blo

SURI RESIDENCE

763 COLLEGE AVE, MENLO PARK, CA 94025 APN 071404140

SHEET INDEX

22 CALIFORNIA ENERGY CODE 22 CALIFORNIA GREEN BUILDING STANDARDS CODE 122 CALIFORNIA FIRE CODE 122 CALIFORNIA REFERENCE STANDARDS CODE

GENERAL NOTES:	SHEET INDEX	PROJECT DIRI	ECTORY
2. ALL CONSTRUCTION AND INSTALLATION SHALL CONFORM TO 2022 CALFORNIA BUILDING, MECHANICA, PLUMBING, ELECTRICAL, ENERGY AND FIRE CODES WITH CITY OF MENLO PARK AMERIOMENTS. 2. THE CONTRACTOR IS TO VERBY ALL CONDITIONS AND DIMENSIONS ON SITE ANY DISCREPANCIES IN THE CONSTRUCTION DOCUMENTS OR CONFLICTS WITH ACTUAL SITE COMDITIONS SHALL EI REQUESTED TO ATTENDION OF THE DISCRINES REFORE	CS COVER SHEET TOPOGRAPHIC SURVEY BT1 BOUNDAMY A TOPOGRAPHIC SURVEY AD.0 AREA PLAN AD.1 STREET, AD.6 AD.6 AD.7	OWNER:	ANUJ SURI 763 COLLEGE AVE, MENLO PARK, CA 94025 (408) 203-7115
PROCEEDING WITH WORK. JO NOT SCALE PROWINGS. WRITTEN DIMENSIONS GOVERN. 4. CLEAR DIMENSIONS SHALL NOT BE ALTERED WITHOUT APPROVAL OF THE DESIGNER. DESIGNER. 6. CONTRACTOR SHALL BE SERVOYSBEE FOR COMPLIANCE WITH ALL APPLICABLE BUILDING GOOS AND RESULTANCES AND SHALL NOTIFY DESIGNER FOR ANY	AD.2. SITE PLANS AD.3. DISTRICT PLANS AD.3. DISTRIC	DRAFTER:	LERIKA LISCANO 4750 ALMADEN EXPY STE 124H176 SAN JOSE, CA 95118 (415) 559-1081 VYLCO@OUTLOOK.COM
BOLIDING CODES AND RESULUTIONS AND SMALL MOTHE DESIGNER OF ARY DISCREPANCIES. 7. VERIPY ALL ARCHITECTURAL DETAILS WITH THE STRUCTURAL DRAWINGS BEFORE THE ORDERING OR INSTALLATION OF ANY ITEM. COORDINATE WITH SHEARWALLS AND ENCLOSED STRUCTURAL POSTS AS REQUIRED. 8. ALL MATERIALS AND EQUIPMENT SHALL BE INSTALLED AS PER MANUFACTURER'S	A4.2 PROPOSED EXTERIOR LEEVATIONS A4.3 FLOOR RARE DIAGRAMS A5.1 BUILDING CROSS SECTIONS A6.1 AD PLANS (FOR BETERNEC ONLY) A6.2 ADULENTERIOR LEEVATIONS AND CROSS SECTIONS (FOR REFERENCE ONLY) LUNGSCAPE LANGYCARP I JAN. AMERICAN STRUCTURE OF THE PROPOSED O	BUILDER: STRUCTURAL ENGINEER:	HAMILTON BUILDERS INC LIC. #B-998293 3565 GLASGOW CT. SAN JOSE, CA 95127 (408) 687-1109 KCBUILDERSGC@GMAIL.COM
INSTRUCTIONS AND PER CODE. ALL APPLIANCES, FIXTURES AND EQUIPMENT ASSOCIATED WITH PLUMBING, ELECTRICAL AND MICHANICAL SYSTEMS MUST BE LISTED BY A NATIONALITY RECOGNIZED AND APPROVED AGENCY. 9. ALL DIMENSIONS ARE TO BE VERNIFEION FIELD (VLL). 10. WINDOW DIMENSIONS NOTED ON DRAWNINGS ARE NOMINAL - REFER TO MANUFACTURE POR POCHE OPENINGS.		CIVIL ENGINEER:	FMD ENGINEERING, INC. 32108 ALVARADO BLVD, II340 UNION CITY, CA 94587 (510) 475-8290 FDUARTE® FMDENGR.COM PORFIRIO OSUNA. PE
REPORTED LINEAR FUN ROUGH OF ENVIRON.		GEOTECHNICAL ENGINEER:	6920 SANTA TERESA SUITE 206 SAN JOSE, CA 95119 (408) 721-2100 SILICON VALLEY SOIL ENGINEERING 1916 O'TOOLE WAY
CONSTRUCTION SHALL CONFORM TO:		ENERGY CONSULTANT:	SAN JOSE, CA 95131 (408) 324-1400 ENERGY CONSULT LLC 1252 W 22ND ST, UNIT #2 SAN PEDRO. CA 90731
2022 CALIFORNIA RESIDENTIAL CODE 2022 CALIFORNIA PLUMBRING CODE 2022 CALIFORNIA MECHANICAL CODE 2022 CALIFORNIA MECHANICAL CODE 2022 CALIFORNIA BELETRICA. CODE 2022 CALIFORNIA ENERGY CODE 2022 CALIFORNIA GEREIA BILL DINNIG STANDARDS CODE		ARBORIST:	(424) 247-7658 BO FIRESTONE TREES & GARDENS BUSARA FIRESTONE, CERTIFIED ABBORIST INVE-8525A 2150 LACEY DR., MILEPITAS, CA 95035 E: BUSARA@ BOFIRESTONE.COM



COMMUNITY DEVELOPMENT DEPARTMENT PLANNING DIVISION

PROJECT DIRECTORY

EXITTING LISE: Couple family residence	AP	APPLICANT: Center Lincom						
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ANUJ SURI 763 COLLEGE AVE, MENLO PARK, CA 94025 (408) 203-7115

NEW SINGLE FAMILY RESIDENCE

LERIKA LISCANO 4750 ALMADEN EXPY STE 124#176 SAN JOSE, CA 95118 VYLCO@ OUTLOOK.COM

PROJECT DESCRIPTION

PROJECT CONSISTS OF DEMOLITION OF AN EXISTING ONE-STORY HOME. CONSTRUCTION OF A NEW TWO-STOR' SINGLE FAMILY RESIDENCE OVER A BASEMENT WITH ATTACHED GARAGE. SEPARATE PERMITS

FIRE SPRINKLERS.
 MINIMUM 3.86 KWDC PV SYSTEM PER TITLE 24 CERTIFICATE OF COMPLIANCE.
 GRAYWATER SYSTEM.

PROJECT DATA

ZONING OCCUPANCY CONSTRUCTION TYPE LOT SIZE LOT WIDTH LOT DEPTH	R3/U VB-SPRINKLERED 8,082 SF 50' 161.54'	
PROPOSED MAIN HOUSE	1ST FLOOR (LIVING)	1.446.17 SF
	2ND FLOOR (LIVING)	1,168.82 SF
	GARAGE TOTAL FAI	446.67 SF 3.061.66 SF (MAX. 3.070.50 SF)> OK
	TOTAL PAL	3,001.00 3F (WHX. 3,070.30 3F) -> OK
	BASEMENT	1,938.84 SF
	LIGHTWELL COVERED BALCONY	345.53 SF 241.58 SF
	OPEN BALCONY	64.87 SF
	FRONT PORCH COVERED PATIO	76.84 SF
	OPEN PATIO	370.35 SF 272.93 SF
	2ND FLOOR STAIRS	
	(not included in FAL) 2ND FLOOR FLEVATOR	79.26 SF
	(not included in FAL)	12.75 SF
PROPOSED ADU (UNDER A SEPARATE PERMIT)		748.86 SF
MAIN HOUSE REQUIRED SETBACKS		


28'-0" 27'-9" MAIN HOUSE MAX. HEIGHT PROPOSED HEIGHT FLOOR AREA LIMIT 1,446.17 SF 446.67 SF 1,168.82 SF 3,061.66 SF < 3,070.50 SF MAX. FAL 748.86 SF 3,810.52 SF 1ST FLOOR GARAGE 2ND FLOOR TOTAL FAL ADU TOTAL FAL


BUILDING COVERAGE 1ST FLOOR GARAGE COVERED PATIO COVERED PORCH

FOR OFFICIAL CITY USE ONLY: DATE: DRAWN BY: LL

COVER SHEET

USE PERMIT SET

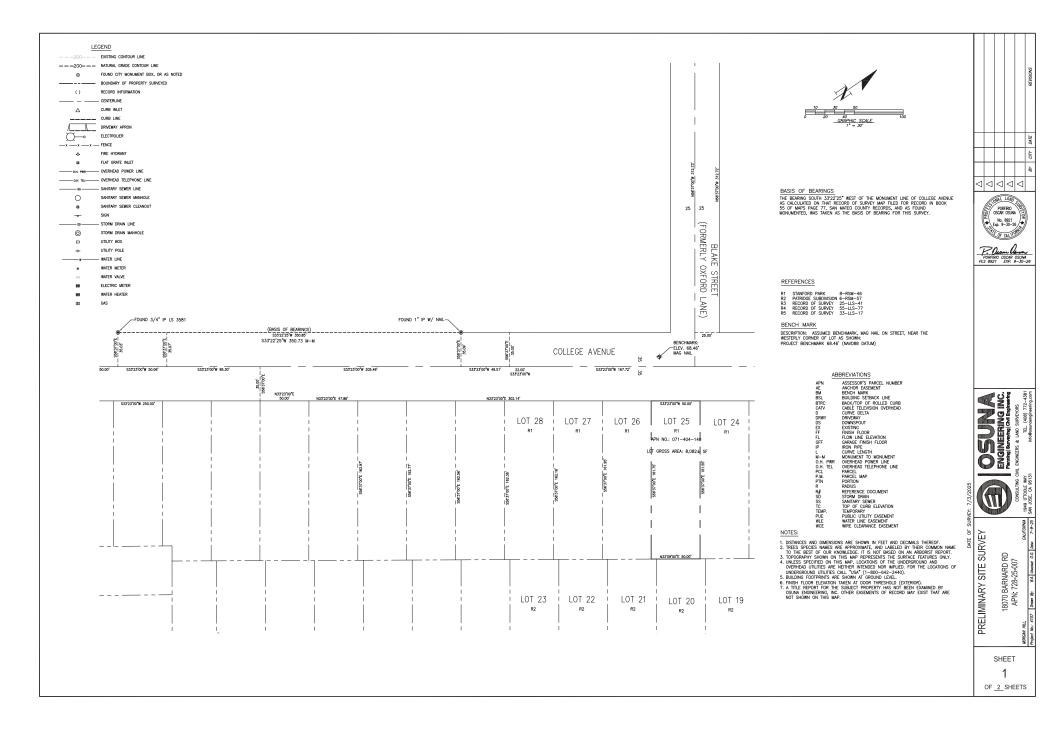

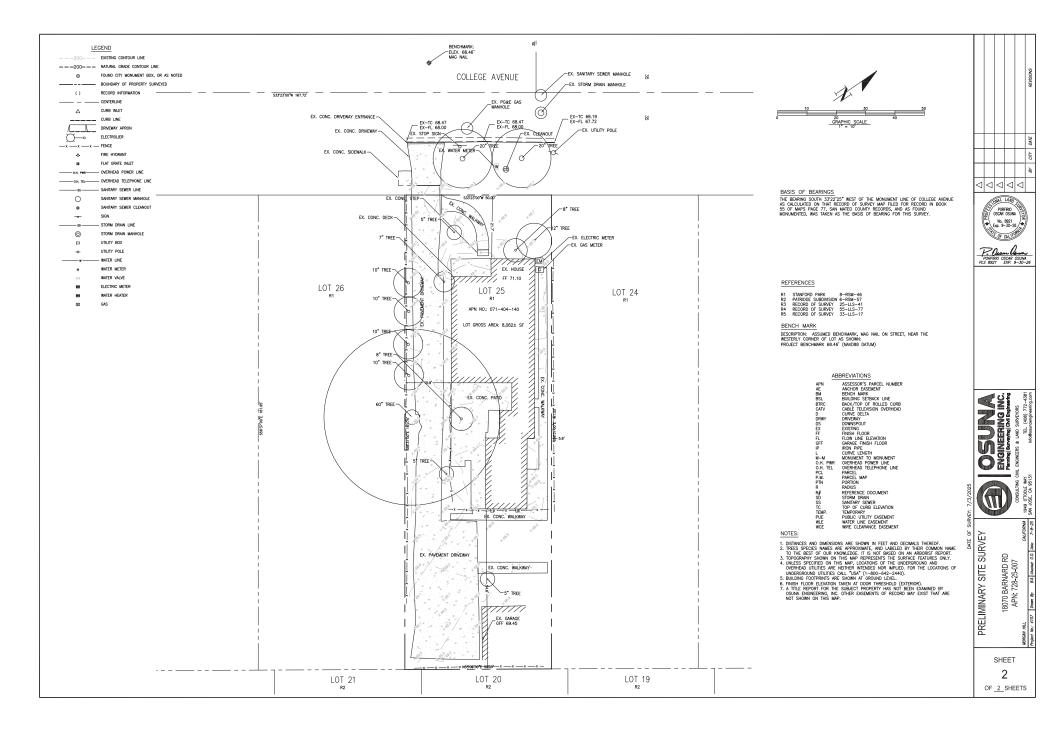

OWNER: ANUJ SURI 763 COLLEGE AVE, MENLO PARK, CA 94025 (408) 203-7115

811

802

RELOCATE (E) TREE TO HERE SEE LANDSCAPE PLAN

761

757

_23" DBH SOUTHERN MAGNOLIA

COLLEGE AVE.

APPROVAL STAMPS:

USE PERMIT SET

DRIVEWAY

7" DBH YEW PINE T.B.R.

DRIVEWAY

DRIVEWAY

EXISTING BUILDING

EXISTING BUILDING

NEW TREE. SEE LANDSCAPE PLAN

_(2) 4" DBH EUROPEAN WHITE BIRCH, T.B.R.

NEW TREE. SEE LANDSCAPE PLAN

7" DBH GLOSSY_PRIVET

EXISTING RESIDENCE_ T.B.R. NEW TREE. SEE LANDSCAPE PLAN

8.5", (2) 8" DBH OLIVE T.B.R.

DRAFTER: LERIKA LISCANO 4750 ALMADEN EXPY 5TE 124#176 SAN 105E, CA 95118 VYLCO@ OUTLOOK.COM

NEW SINGLE FAMILY RESIDENCE 763 COLLEGE AVE, MENLO PARK, CA 94025

DATE: 10/16/2025 DRAWN BY: LL

AREA PLAN

A0.0

EXISTING BUILDING

EXISTING BUILDING

EXISTING BUILDING

EXISTING BUILDING

EXISTING BUILDING

EXISTING BUILDING



826-832

824

810-812

808

774-784-786

EXISTING BUILDING

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EXISTING BUILDING

EXISTING BUILDING

PARTRIDGE AVE.

ABBREVIATIONS EXISTING TO REMAIN



1 SIKELISCA A0.1 SCALE: 1/8" = 1' - 0"



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NEW SINGLE FAMILY RESIDENCE 763 COLLEGE AVE, MENLO PARK, CA 94025




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10/16/2025 DRAWN BY: LL

STREETSCAPE

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8) MOVABLE BARRIERS OF CHAIN LINK FENCING SECURED TO CEMEN BLOCKS MAY BE SUBSTITUTED FOR FIXED FENCING IF THE PROJECT ARBORIST AND CITY ARBORIST AGREE THAT THE FENCING WILL HAVE TO BE MOVED TO ACCOMMODATE CERTAIN PHASES OF CONSTRUCTION. THE BUILDER MAY NOT MOVE THE FENCE WITHOUT


AUTHORIZATION FROM THE PROJECT ARBONIST OR CITY ARBORIST.


4) PLACE A 6-INCH LAYER OF COARSE MULCH OR WOODCHIPS COVERED
WITH 3/4-INCH PLYWOOD OR ALTERNATIVE WITHIN THE TPZ OVER
BARE GROUND PRIOR TO CONSTRUCTION ACTIVITY.

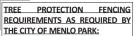



(E)	EXISTING TO REMAIN
(N)	NEW
T.B.R.	TO BE REMOVED
TPZ	TREE PROTECTION ZONE

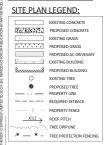

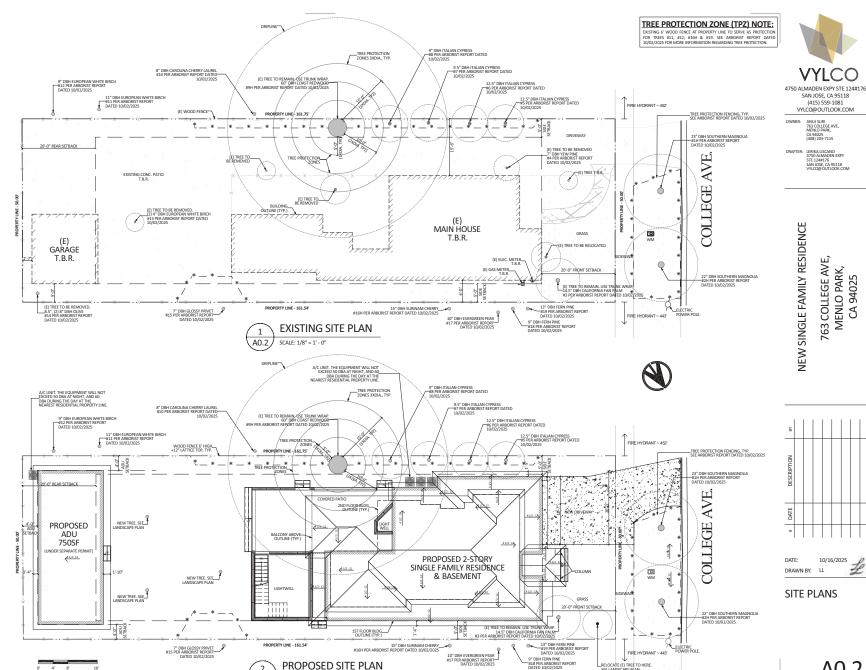

(A0.2

SCALE: 1/8" = 1' - 0"

(415) 559-1081

CA 94025 (408) 203-7115

763 COLLEGE AVE, MENLO PARK, CA 94025

10/16/2025

A0.2

USE PERMIT SET

RELOCATE (E) TREE TO HERE.





4750 ALMADEN EXPY STE 124#176 SAN JOSE, CA 95118 (415) 559-1081 VYLCO@ OUTLOOK.COM

OWNER: ANUJ SURI 763 COLLEGE AVE, MENLO PARK, CA 94025 (408) 203-7115

DRAFTER: LERIKA LISCANO 4750 ALMADEN EXPY 5TE 124#176 SAN 105E, CA 95118 VYLCO@ OUTLOOK.COM

NEW SINGLE FAMILY RESIDENCE 763 COLLEGE AVE, MENLO PARK, CA 94025

DATE:


10/16/2025 DRAWN BY: LL

EXISTING FLOOR PLAN

A0.3


SHEET: USE PERMIT SET

APPROVAL STAMPS:

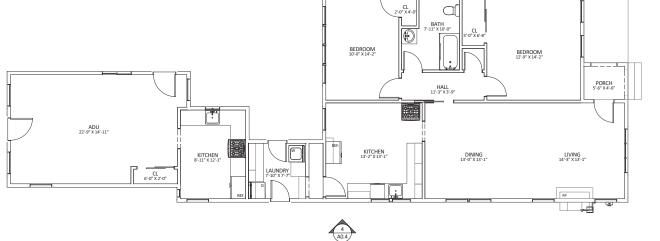

EXISTING FLOOR PLAN 1 SCALE: 1/4" = 1' - 0" A0.3



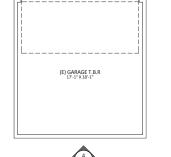

6 A0.4




EXISTING GARAGE FLOOR PLAN 2 A0.3 SCALE: 1/4" = 1' - 0"

ABBREVIATIONS

DEMOLITION WALL

LEGEND



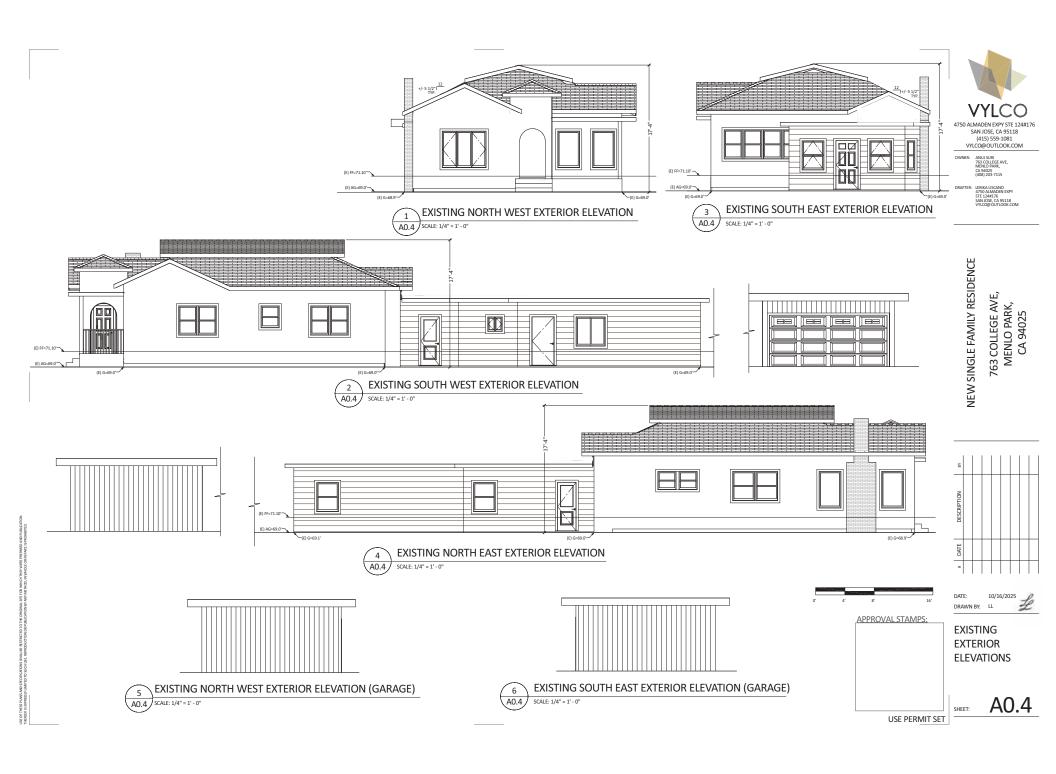

- DELEARMINGUITO INTERPAIRES
 DELEARMINGUITO INTERPAIRES
 CHAMPICALES MAIL BE INSTALLED WITH INSULATED
 CHAMPICALES MAIR AMERITACES SHALL BE INSTALLED WITH INSULATED
 CHAMPICALES SEGIFICATIONS.

 B. RIBERALES OPENING SHALL BE EQUIPPED WITH A TIGHT FITTING, CLOSEABLE
 BITERALE OPENING SHALL BE EQUIPPED WITH A TIGHT FITTING, CLOSEABLE
 BITERAL OF CALASS SOOR.

 C. RIBERALES SHALL HAVE A FILLE DAMPER AND AN OUTSIDE ARI INTAKE WITH
 DAMPER.
- ONLY GAS OR ELECTRICAL APPLIANCE FIREPLACES ARE TO BE LISED
- E. SPARK ARRESTORS SHALL BE INSTALLED ON ALL CHIMNEYS INCLUDING OUTSIDE

- APPLIANCES: THE CONTRACTOR SHALL PROVIDE RESIDENTIAL EQUIPMENT WHICH IS U.L. LABELED. PROVIDE, TO THE OWNER, ALL MANUFACTURER'S STANDARD WRITTEN WARRANTIES, OWNER'S MANUALS, AND STANDARD ACCESSORIES. CONTRACTOR SHALL INSTALL THE APPLIANCES WHERE INDICATED ON DRAWINGS AND AS REQUIRED BY ALL CODES AND LISTINGS, APPLIANCE TYPES, STYLES, COLORS, ETC., SHALL BE SELECTED BY OWNER

- <u>CAULKING</u>: ALL JOINTS AND PENETRATIONS AT EXTERIOR WALLS, CEILINGS AND FLOOR ASSEMBLIES SHALL BE FULLY CAULKED AND SEALED.

- EXTERIOR PLASTER LATH: EXTERIOR PLASTER LATH SHALL BE OF AN APPROVED, PARPER BACKED, CORROCION RESISTANT METAL OR WINE FABRIC AND SHALL BE SILE PURRING. [1,4* MINL.) APPLY LATH OFER WALL LINDER/LAWNEST WITH THE LONG DIMERSION HOROCONTAL AND LAP AN INL. 1/2* AT THE SIDES AND MIN. 1.* AT THE SIDES SHOWN THE SHALL BE SECRIEBLY THE FOREITHER WITH AN IN I.S. G. WIRE, REINFORCEMENT SHALL BE SECRIEBLY THE FOREITHER WITH AN III. S.G. WIRE, REINFORCEMENT SHALL BE BE SECURETY IED TO DEFINE WITH A MIN ILE GA. WIRE. REINFORCEMENT SHALL USEQUITAL CONNERS OF THE WITH SHALL BE AGRIED AROUND CONNERS AT LEAST ONE SUPPORT. A WEST SCHEED SHALL BE PROVIDED AT OR BELOW THE FOUNDATION LINE ON ALCRETED SHALL BE PROVIDED AT OR BELOW THE ADJACENT GRADE. THE SECRED SHALL BLOW TRAPPED WAITER TO DRAIN TO THE OUTSIDE. BOTH THE SCENLED AND APPER UNDERSTANMENT SHALL TERMINATE ADJACENT SHALL ON THE ATTACHMENT FLANGE OF THE SCREED. NAILING OF METAL LATH SHALL BE AT A MAX. OF 6 O.C. EACH WAY USING EITHER 11 GA. X 1-1/2" LONG X 7/16" HEAD NAILS OR 16 GA. STAPLES WITH 7/8" LEGS.

- EXTERIOR PLASTER: EXTERIOR PLASTER SHALL BE PORTLAND CEMENT APPLIED IN THIREE COATS TO A MIN. THICKNESS OF 7/8". SEE EXTERIOR ELEVATIONS FOR TEXTURE VARIATIONS.

- <u>GYPSIAM WALLBOARD</u>; ALL INTERIOR WALL AND CELING FACES ARE TO BE SHEATHED WITH 1/2" GYPSIAM WALLBOARD EXCEPT WHERE NOTED TO USE 5/8" "TYPE "\" WALLBOARD. THE, TEXTURE AND POINT OF REPORT ACCESSIONS TO FINISH SCHEDULE. USE WATER RESISTANT GYPSIAM BACKING BOARD AT WALLS TO RECEIVE CERAMIC THE COVERING. ALL GAPS AND PERFERTATIONS AT 5/8" TYPE "X" WALLBOARDS HALLE RETILED WITH THE FEITHER. WALL STUDS. PLATES. BLOCKING. ETC., AS FOLLOWS:

- A 1/2" WALLBOARD 4d CEMENT COATED BOX NAIL OR 1-3/8" x 14 GA. ACID-ETCHED, PHOSPHATE COATED
- B NAIL OR 4d "DRYVITE" NAIL AT 7" O.C. C 5/8" TYPE "X" WALLBOARD 6D "COOLER" NAILS AT 7" O.C.

BATHROOM NOTES:

- A. BATHTUB AND SHOWER FLOORS AND WALLS ABOVE BATHTUBS WITH INSTALLED SHOWER HEADS AND IN SHOWER COMPARTMENTS SHALL BE FINISHED WITH A NONABSORBENT SURFACE. SUCH WALL SURFACES SHALL EXTEND TO A HEIGHT OF NOT LESS THAN 6 FEET ABOVE THE FLOOR. CRC R307.2.
- INUT LESS THAN 6 FEET ABOVE THE FLOOR, CRC R307.2.

 B. GYPSUM BOARD SHALL NOT BE USED WHERE THERE WILL BE DIRECT EXPOSURE TO WATER, OR IN AREAS SUBJECT TO CONTINUOUS HIGH HUMIDITY, CRC R702.3.7.

STAIR HANDRAILS NOTES:

- EVERY STAIRWAY SHALL HAVE AT LEAST ONE HANDRAIL AND EVERY OPEN SIDE OF
 A STAIRWAY SHALL HAVE A GUARD COMPLYING WITH CRC SECTION R312. HANDRAILS SHALL BE CONTINUOUS FOR THE FULL LENGTH OF A FLIGHT, WITH THE EXCEPTION OF NEWEL POSTS.
- C) HANDRAILS MOUNTED ON A WALL SHALL HAVE A MIN. 1-1/2" SPACE BETWEEN
- THE WALL AND THE HANDRAIL

 D) THE HANDRAIL FORTION OF HANDRAILS SHALL HAVE DIAMETER (IF ROUND) IN THE PROMOMEN FOUND OF PROMOMENTS AND LET WAS COMMENTED BY THE ADDRESS OF THE A

- TREAD MOSING.

 I HANDRAIL SANLE E CAPABLE OF SUPPORTING A POINT LOAD OF 200 POUNDS AT ANY POINT, IN ANY DIRECTION.

 STATE OF THE STATE
- H) INSTALL CR LAURENCE OR SIMILAR RAILING AND GUARDRAILS PER MANUFACTURE'S INSTRUCTIONS. ICC-ES REPORT ESR-3269 AND IS:

GUARDS NOTES:

- A) ALL EDGES OF INTERIOR AND EXTERIOR FLOORS, STAIRS, AND RAMPS MORE THAN 30" HIGHER THAN ADJACENT SURFACES SHALL HAVE GUARDS MEETING THE REQUIREMENTS OF CRC SECTION R312.
- B) ALL GUARD RAILINGS AND WALLS SHALL BE A MIN. 42" HIGH, EXCEPT AT STAIRS WHERE THE TOP RAIL OF THE GUARD MAY BE A MIN. OF 34" ABOVE THE NOSING LINE.


 C) GUARDS SHALL BE CONSTRUCTED TO SUPPORT A POINT LOAD OF 200 POUNDS.
- C GLAMES SHALL SE CONSTRUCTED TO SUPPORT A POINT LIGAD OF 200 POUNDS APPLIED HAVE DESCRIPTION AT THESE TO DE CO. ACTIONALLY IN THE PRIME SHAPE OF THE SHAPE OF THE
- FABRICATION.

 F) INSTALL CR LAURENCE OR SIMILAR RAILING AND GUARDRAILS PER MANUFACTURE'S INSTRUCTIONS, ICC-ES REPORT ESR-3269 AND ISS-ES REPORT

ESR-3842





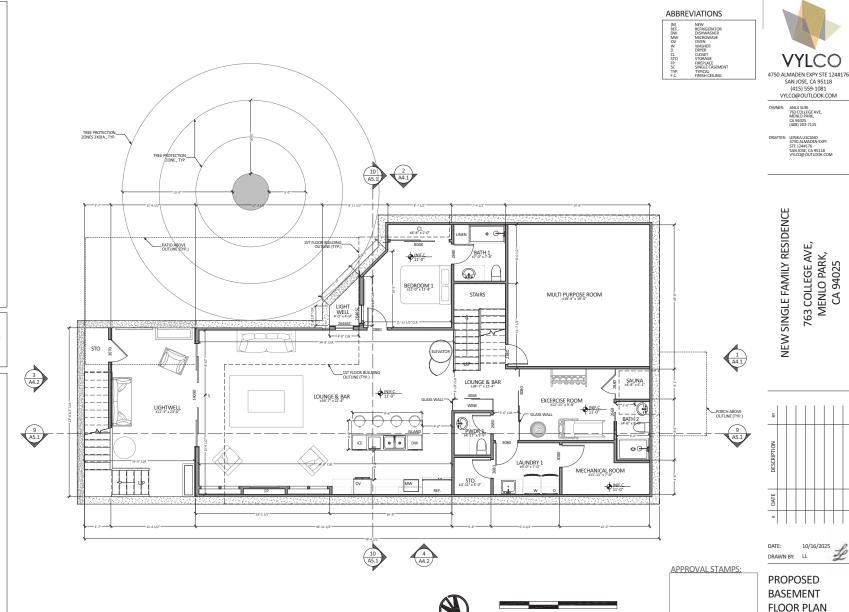

PROPOSED BASEMENT FLOOR PLAN

A2.1

SCALE: 1/4" = 1' - 0"

SHEET: USE PERMIT SET

763



NEW SINGLE FAMILY RESIDENCE 763 COLLEGE AVE, MENLO PARK, CA 94025



DATE: 10/16/2025


DRAWN BY: LL

PROPOSED FIRST

FLOOR PLAN

SHEET:

USE PERMIT SET

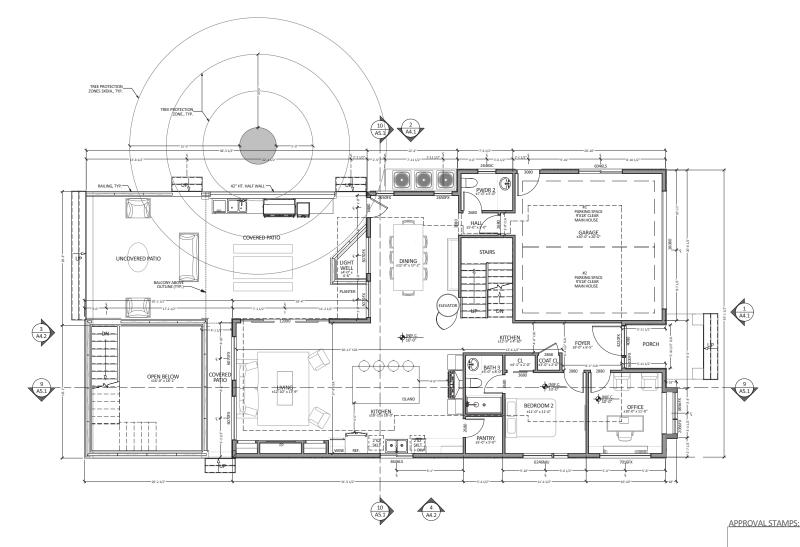

ABBREVIATIONS

NEW	
DISHWASHER	
REFRIGERATOR	
CLOSET	
FIREPLACE	
FIXED	
LEFT SLIDING	
SINGLE CASEMENT	
TYPICAL	
FINISH CEILING	
	DISHWASHER REFRIGERATOR CLOSET FIREPLACE FIXED LEFT SLIDING SINGLE CASEMENT TYPICAL

LEGEND

2X6 EXTERIOR WALL

PROPOSED FIRST FLOOR PLAN A2.2

SCALE: 1/4" = 1' - 0"







4750 ALMADEN EXPY STE 124#176 SAN JOSE, CA 95118 (415) 559-1081 VYLCO@OUTLOOK.COM OWNER: ANUJ SURI 763 COLLEGE AVE, MENLO PARK, CA 94025 (408) 203-7115

DRAFTER: LERIKA LISCANO 4750 ALMADEN EXPY 5TE 124#176 SAN 105E, CA 95118 VYLCO@ OUTLOOK.COM

NEW SINGLE FAMILY RESIDENCE 763 COLLEGE AVE, MENLO PARK, CA 94025




DATE:

10/16/2025 DRAWN BY: LL

PROPOSED SECOND FLOOR PLAN

SHEET:

USE PERMIT SET

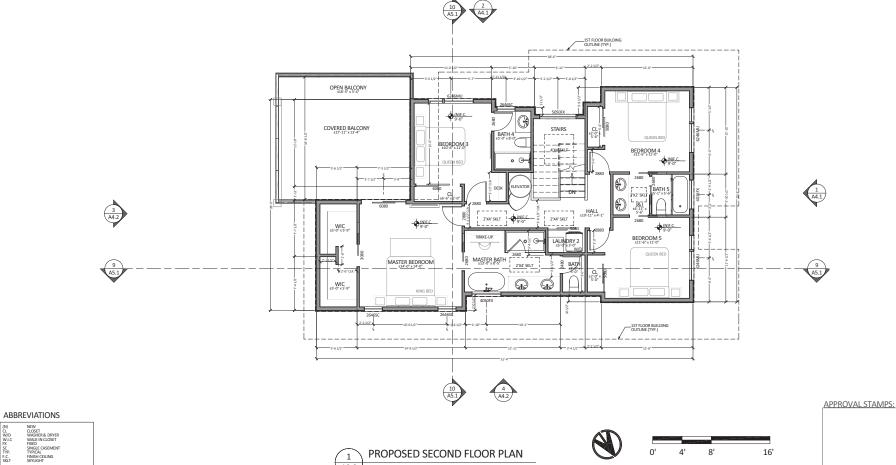


PROPOSED SECOND FLOOR PLAN


SCALE: 1/4" = 1' - 0"

A2.3

LEGEND 2X6 EXTERIOR WALL 1-ANY CALIFORNIA FRAMED ROOF AREAS ARE TO BE ENTIRELY FILLED WITH CLOSED CELL SPRAY FOAM PLASTIC INSULATION OR, IF ACCESS IS AVAILABLE, TO BE INSULATED AS PER DETAILS WITH A MIXTURE OF SPRAY FOAM AND BATT INSULATION.

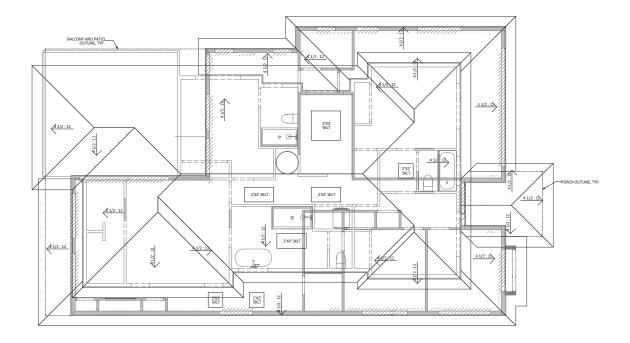



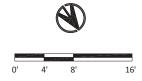



OWNER: ANUJ SURI 763 COLLEGE AVE, MENLO PARK, CA 94025 (408) 203-7115

DRAFTER: LERIKA LISCANO 4750 ALMADEN EXPY 5TE 124#176 SAN JOSE, CA 95118 VYLCO@ OUTLOOK.COM

NEW SINGLE FAMILY RESIDENCE 763 COLLEGE AVE, MENLO PARK, CA 94025



DATE:

10/16/2025 DRAWN BY: LL

PROPOSED ROOF PLAN

SHEET:

USE PERMIT SET



4750 ALMADEN EXPY STE 124#176 SAN JOSE, CA 95118 (415) 559-1081 VYLCO@OUTLOOK.COM

OWNER: ANUJ SURI 763 COLLEGE AVE, MENLO PARK, CA 94025 (408) 203-7115


DRAFTER: LERIKA LISCANO 4750 ALMADEN EXPY STE 124#176 SAN JOSE, CA 95118 VYLCO@ OUTLOOK.COM

NEW SINGLE FAMILY RESIDENCE 763 COLLEGE AVE, MENLO PARK, CA 94025

DATE:

10/16/2025 DRAWN BY: LL

PROPOSED EXTERIOR ELEVATIONS

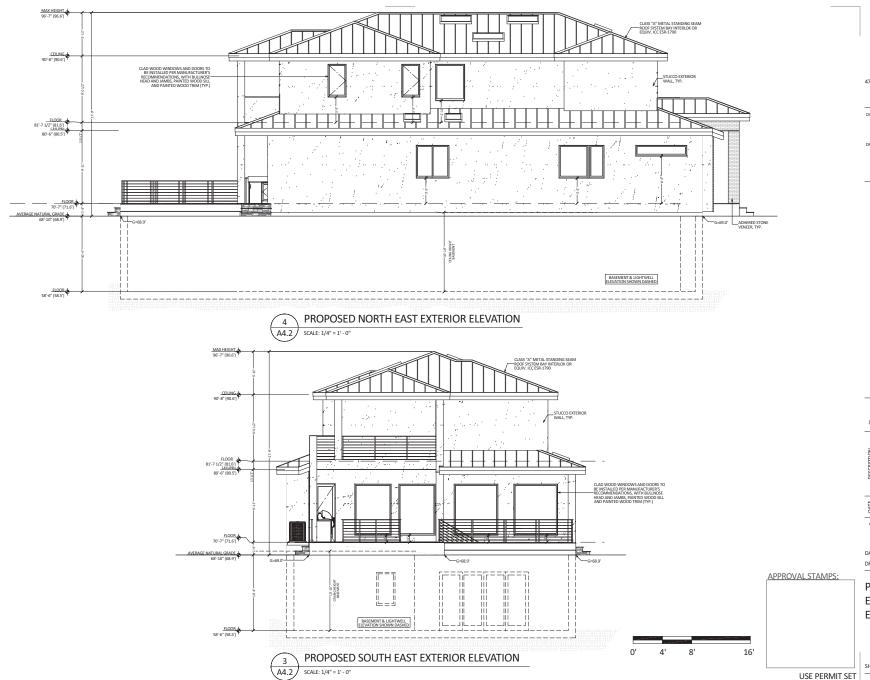

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NEW SINGLE FAMILY RESIDENCE 763 COLLEGE AVE, MENLO PARK, CA 94025




DATE: 10/16/2025


DRAWN BY: LL

PROPOSED EXTERIOR ELEVATIONS

FIRST FLOOR AREA DIAGRAM A4.3 SCALE: 1/8" = 1' - 0"

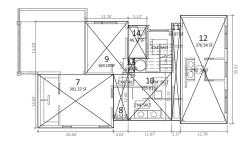

SECOND FLOOR AREA DIAGRAM 2 SECOND FI A4.3 SCALE: 1/8" = 1' - 0"

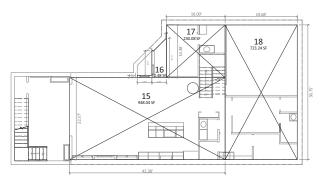

BASEMENT FLOOR AREA DIAGRAM 3 SCALE: 1/8" = 1' - 0" A4.3



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NEW SINGLE FAMILY RESIDENCE 763 COLLEGE AVE, MENLO PARK, CA 94025

	ONE OF THE ATTIC SP TS COMPUTER ADEC	ACE MEETS	THE DEFINIT	AREA CAI			R ERRORS FROM ROL	JNDING - TOTALS
SECTION 1 2 3 4 5 6 GARAGE	FIRST FLOOR DIMENSIONS (FT) 7-63X3.00 19.96X17.29 38.29X19.04 15.51X18.16 5.50X12.27 21.01X21.26	SQ.FT. 22.89 345.10 729.04 281.66 67.48 446.67	SECTION 7 8 9 10 11 12 13 14	SECOND FLOOR DIMENSIONS (F 20.60X14.63 4.01X12.60 11.76X14.38 11.87X13.11 2.37X26.53 12.76X29.51 1.75X3.82 5.12X9.01	301.37 50.52	SECTION 15 16 17 18	BASEMENT DIMENSIONS (FT) 42.38X22.37 16.00X14.38 19.68X36.75	SQ.FT. 948.04 37.48 230.08 723.24
FIRST FLO	OR AREA SUBTOTAL:	1,892.84	SECOND F	LOOR AREA SUBT	OTAL=1,168.82	BASEMEN	IT FLOOR AREA SUBT	OTAL=1,938.84
	UNTABLE FLOOR ARE UARE FOOTAGE OF A		D SECOND F	LOOR= 3,061 5,000	66 SF < 3,070. 50 SF	50 SF MAX.	FAL	

SECTION	LOT COVERAGE DIMENSIONS (FT)	SQ.FT.	(NOT COUN	BAYS AND BOXES ITED AS FLOOR AREA O	R LOT COVERAGE
A	5.50X5.89	32.39	SECTION	DIMENSIONS (FT)	SQ.FT.
AA	5.00X8.89	44.45	C	1.50X6.97	10.45
В	21.42X17.29	370.35	TOTAL=		10.45
FIRST FLOO	R AREA	1,892.84			
TOTAL LOT COVERAGE 2,340,03 (28%)					
(< 35% MA)	(. 2,829 SF)				



DATE: 10/16/2025 DRAWN BY: LL

FLOOR AREA


DIAGRAMS

SHEET:

USE PERMIT SET





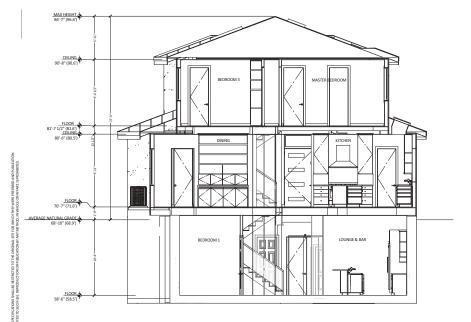

BUILDING SECTION

SCALE: 1/4" = 1' - 0"



BUILDING CROSS

DATE:

DRAWN BY: LL

SECTIONS

10/16/2025

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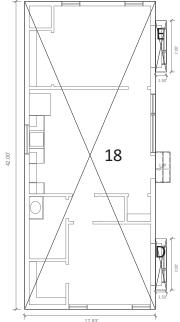
NEW SINGLE FAMILY RESIDENCE

763 COLLEGE AVE, MENLO PARK, CA 94025


A5.1

USE PERMIT SET








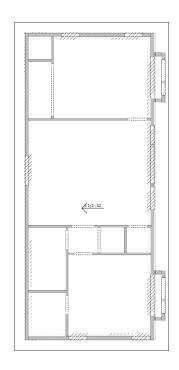





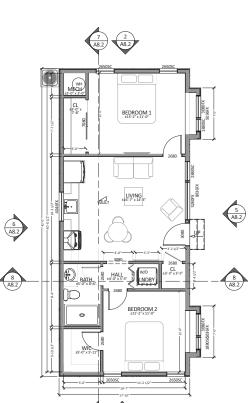

LEGEND 2X6 EXTERIOR WALL 2X4 INTERIOR WALL





ADU PLANS (FOR

REFERENCE ONLY)

USE PERMIT SET

NEW SINGLE FAMILY RESIDENCE 763 COLLEGE AVE, MENLO PARK, CA 94025

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OWNER: ANUJ SURI 763 COLLEGE AVE, MENLO PARK, CA 94025 (408) 203-7115


DRAFTER: LERIKA LISCANO 4750 ALMADEN EXPY STE 124#176 SAN JOSE, CA 95118 VYLCO@ OUTLOOK.COM




10/16/2025 DRAWN BY: LL

A8.1



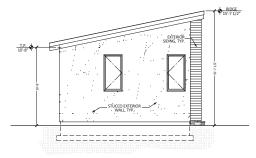




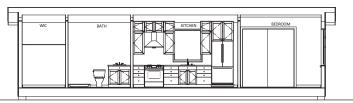





PROPOSED NORTH WEST SCALE: 1/4" = 1' - 0"

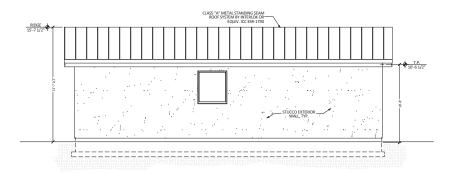












USE PERMIT SET



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DRAFTER: LERIKA LISCANO 4750 ALMADEN EXPY STE 124#176 SAN JOSE, CA 95118 VYLCO@ OUTLOOK.COM

NEW SINGLE FAMILY RESIDENCE 763 COLLEGE AVE, MENLO PARK, CA 94025

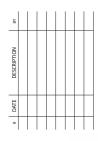

DATE: 10/16/2025 DRAWN BY: LL

ADU EXTERIOR

ELEVATIONS AND CROSS SECTION (FOR REFERENCE ONLY)





* NOTES (E) = EXISTING

SCALE 1/8" = 1'-0"

JOB SURI

HEED CRAIMING ARE INSTRUMENTS OF SERVICE, ISSUED FOR A CRE-TIME SHALL SESSIVE FOR A CRE-TIME SHALL ASSURE RESPONSABILITY FOR THE LANGEAFE ARCHITECT RELANS ALL RECESSARY PERMITS REQUIRED TO PERFORM WORK SHOULD ON PLANS. BASE INFORMATION HAS BEEN PROVIDED BY THE CHINER CATEFORM WORK SHOULD NO PLANS. BASE INFORMATION HAS BEEN PROVIDED BY THE CHINER CATEFORM WORK SHOULD NO PLANS. BASE INFORMATION HAS BEEN PROVIDED BY THE CHINER CATEFORM WORK SHOULD NO PLANS. BASE INFORMATION HAS BEEN PROVIDED BY THE CHINER CATEFORM WORK SHOULD NO PLANS. BASE INFORMATION HAS BEEN PROVIDED BY THE CHINER CATEFORM WORK SHOULD NO PLANS. BASE INFORMATION HAS BEEN PROVIDED BY THE CHINER CATEFORM WORK SHOULD NO PLANS. BASE INFORMATION HAS BEEN PROVIDED BY THE CHINER CATEFORM WORK SHOULD NO PLANS. BASE INFORMATION HAS BEEN PROVIDED BY THE CHINER SHOULD NOT PROVIDED BY THE C

REVISIONS BY

KAREN AIKEN \$ ASSOCIATES LANDSCAPE ARCHITECTS 8262 RANCHO REAL GILROY CA. 95626 CALIF. REG. #2239 (408) 851-6215 KAREN®KAA DESIGN

PARK LANDSCAPE PLAN

BURI REBIDENCE COLLEGE AVENUE, MENLO <u>6</u>93

No. 2239 Exp. 8-31-26

LANDSCAPE AP

DATE 10-02-25 SCALE 1/8"=1'-0"

DRAWN DI FPD